
# TAKOTNA TRIBAL COUNCIL

## TAKOTNA WASHETERIA FILTER AND SEPTIC TAKOTNA, ALASKA

35% DESIGN DRAWINGS OCTOBER 03, 2013

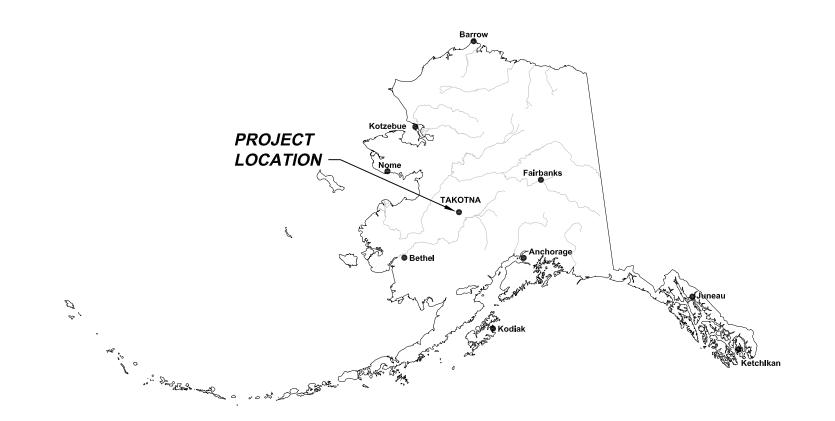

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COVER SHEET

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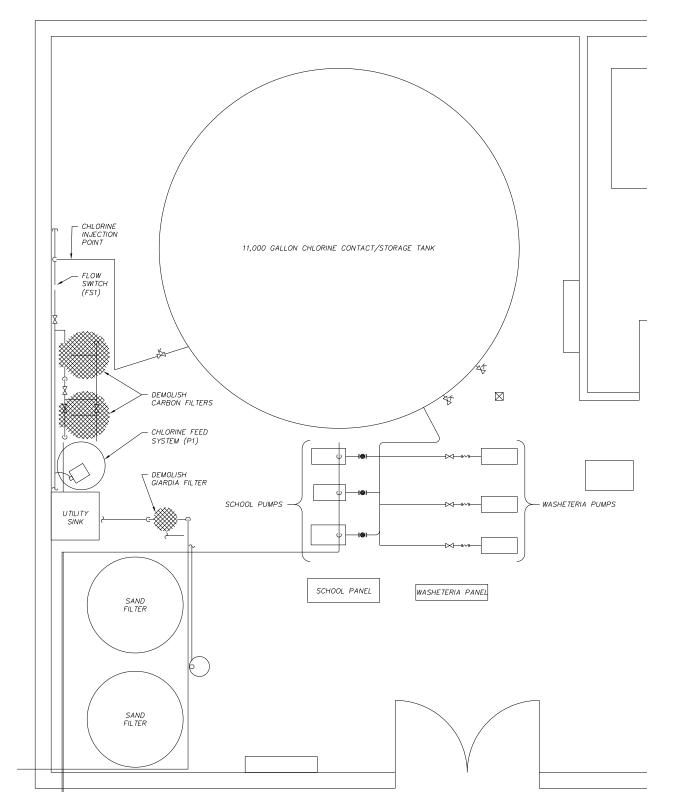


JOB NUMBER: 70108.13 SCALE: AS SHOWN

DRAWING TITLE: WASHETERIA DEMOLITION PLAN


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C-1



#### NOTES

- 1. REMOVE EXISTING GIARDIA FILTER AND PRESSURE GAUGE.
- REMOVE TWO EXISTING CARBON FILTER AND ASSOCIATED HARDWARE. VALVES FROM RAW WATER LINE TO REMAIN.
- 3. DO NOT REMOVE OR DAMAGE BACKWASH LINES OR VALVES.

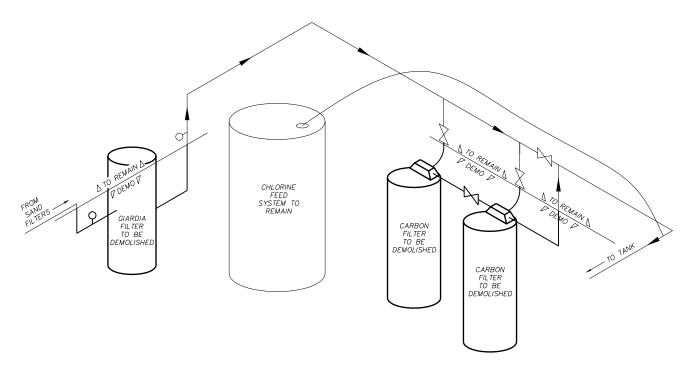

DEMOLITION SCHEMATIC

C-1 SCALE: N.T.S.

DEMOLITION PLAN

C-1 SCALE: N.T.S.

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DRAWING TITLE: WASHETERIA SITE PLAN, FLOW DIAGRAM AND GENERAL NOTES

SHEET: OF

**GENERAL NOTES** 

ALL ADDITIVES AND MATERIALS USED FOR THE POTABLE WATER SYSTEM SHALL BE APPROVED FOR USE BY THE NATIONAL SANITATION FOUNDATION (NSF) STANDARDS, NSF 61, NSF 53, AS

2. ALL MATERIALS FOR THE POTABLE WATER SYSTEM SHALL BE LEAD-FREE. ONLY LEAD FREE PIPE, FLUX, AND SOLDER SHALL BE

3. DESIGN DRAWINGS ARE SCHEMATIC IN NATURE, THEY ARE NOT INTENDED TO BE DETAILED DRAWINGS.

4. PROVIDE AIR GAPS AS REQUIRED BY PLUMBING CODE.

5. PROVIDE BACKFLOW AND CROSS CONNECTION CONTROL PER 18AAC80.

6. PIPING SHOWN IS SCHEDULE 40 PVC.

#### SCOPE OF WORK

DEMOLISH EXISTING GIARDIA FILTER AND CARBON FILTERS AS

2. INSTALL STAGE ONE AND STAGE TWO FILTERS AND ASSOCIATED VALVES AND PIPING.

3. DISINFECT SYSTEMS AND DISPOSE OF NEUTRALIZED WATER PER THE REQUIREMENTS OF ANSI/AWA C651, C652, C653 AS APPLICABLE. PRESSURE TESTING MAY BE COINCIDENT PER ASNI/AWWAC605.

4. UPON COMPLETION OF WORK, PERFORM TOTAL COLIFORM TESTING PER ADEC REQUIREMENTS PRIOR TO ESTABLISHMENT OF SERVICE TO WATER SYSTEM.

**DESIGN CRITERIA** 

WATER SOURCE: SURFACE

POPULATION\*: CURRENT: 50 100 DESIGN:

PER CAPITA WATER USE\*: WATERING POINT:

19 GPCPD (RECENT) WATER DISTRIBUTION: 55 GPCPD (FUTURE)

AVERAGE DAILY DEMAND\*: CURRENT:

WASHETERIA: SCHOOL: TOTAL: 5,500 GPD

MAXIMUM DAILY DEMAND\*:
CURRENT: 3,154 GPD
FUTURE: 16,254 GPD

PEAK HOURLY DEMAND\*:

5.9 GPM (CURRENT MAXIMUM FILTRATION RATE: 7 GPM)
21 GPM

PEAK INSTANTANEOUS DEMAND\*: CURRENT: 55 GPM FUTURE: 100 GPM

SOURCE PUMPING RATE\*: 37 GPM

<u>CT TREATMENT:</u>
THE SYSTEM CAN MEET THE CT REQUIREMENTS FOR NORMAL AVERAGE AND PEAK FLOW THE SYSTEM CAN MEET THE CT REQUIREMENTS FOR NORMAL AVERAGE AND PEAR FLOW RATES (12 GPM AND 45 GPM RESPECTIVELY). ASSUMING A WATER TEMPERATURE OF 5 DEGREES CELSIUS, BAFFLE FACTOR OF 10%, 0.5 LOG TREATMENT, pH OF 6.5, AND A MINIMUM WATER STORAGE CAPACITY OF 7,800 GALLONS, THE SYSTEM CAN ADJUST FREE CHLORINE LEVELS TO MEET CT REQUIREMENTS. AT 12 GPM FLOW RATE, THE SYSTEM WOULD HAVE TO MAINTAIN 0.3 MG/L FREE CHLORINE. AT 45 GPM FLOW RATES, THE SYSTEM WOULD HAVE TO MAINTAIN 1.2 MG/L FREE CHLORINE.


<u>PRE-FILTERS:</u>
SAND FILTERS ARE INSTALLED BEFORE THE TANKS TO REMOVE SILT AND LARGE PARTICLES PRIOR TO THE TREATMENT UNITS.


PROPOSED FILTERS: STAGE 1:

TWO (2) MUNI-1-2FL-304 MUNICIPAL HURRICANE FILTRATION SYSTEM CARTRIDGES WITH HC/170-5 HURRICANE HIGH PERFORMANCE FILTERS MANUFACTURED BY HARMSCO MUNICIPAL, OR APPROVED EQUAL.

TWO (2) MUNI-1-2FL-304 MUNICIPAL HURRICANE FILTRATION SYSTEM CARTRIDGES WITH HC/170-LT2 HURRICANE ABSOLUTE RATED FILTERS MANUFACTURED BY HARMSCO MUNICIPAL OR APPROVED EQUAL.

\* DATA FROM G.V. JONES WATER PLANT UPGRADE DESIGN - 1/6/2004

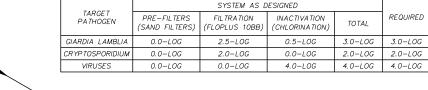

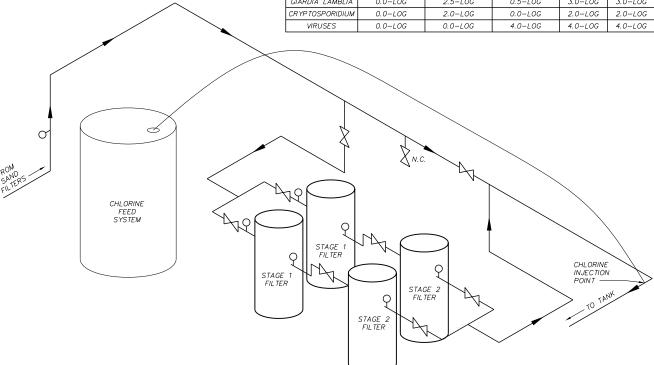



INJECTION POINT

FLOW SWITCH

(FS1)

UTILITY SINK

CHLORINE FEED

SCHOOL PUMPS

SYSTEM (P1)

SAND FILTER

FILTER

NEW FILTERS -

11,000 GALLON CHLORINE CONTACT/STORAGE TANK

CHLORINE CONTACT DESIGN CRITERIA MAX CT VOLUME PROVIDED: 10,394 GALLANS


SCHOOL PANEL

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WASHETERIA PANEL

- WASHETERIA PUMPS


**WASHETERIA PIPING SCHEMATIC** 

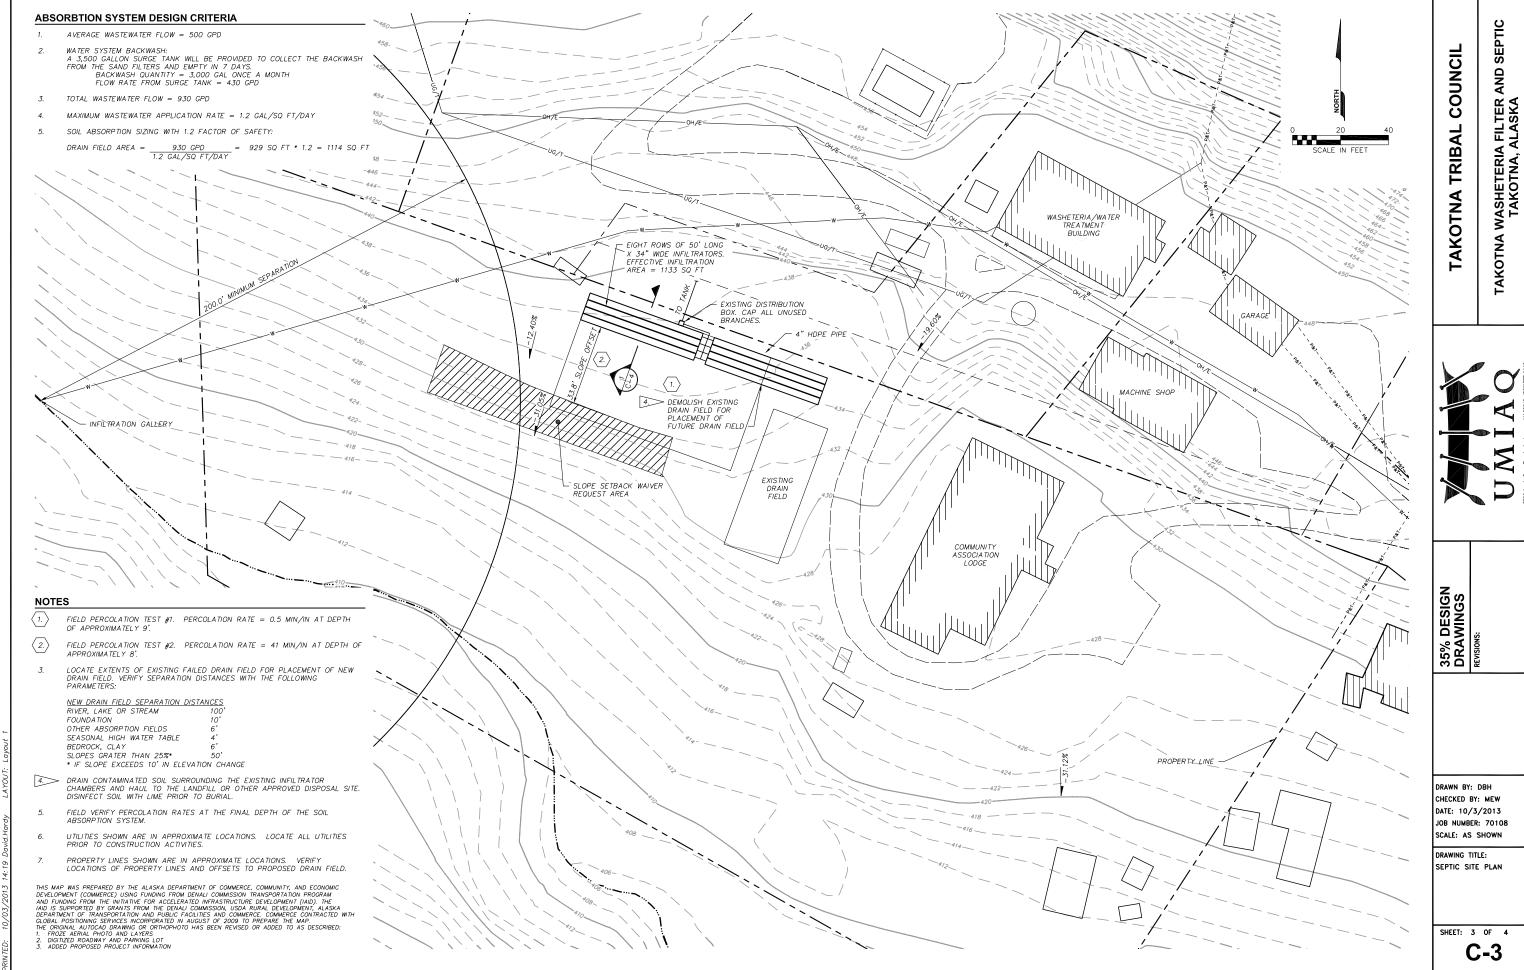


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DRAWING TITLE: SEPTIC DETAILS

SHEET: 4 OF 4

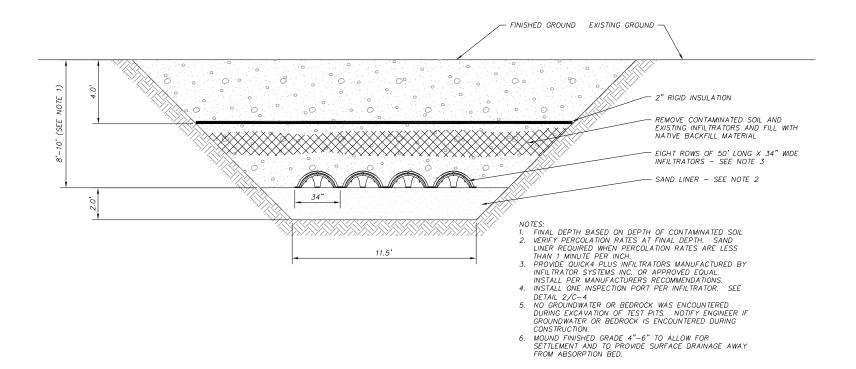

DRAIN FIELD SECTION

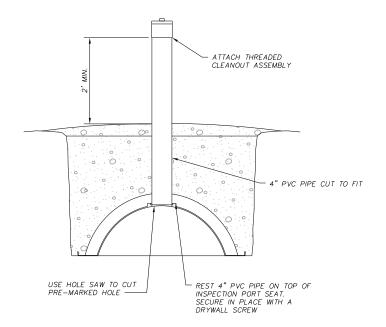

**INSPECTION PORT DETAIL** 

SCALE: N.T.S.