
TAKOTNA TRIBAL COUNCIL

TAKOTNA WATER TREATMENT PLANT UPGRADE AND SEPTIC DRAINFIELD REPLACEMENT TAKOTNA, ALASKA

35% DESIGN DRAWINGS DECEMBER 16, 2013

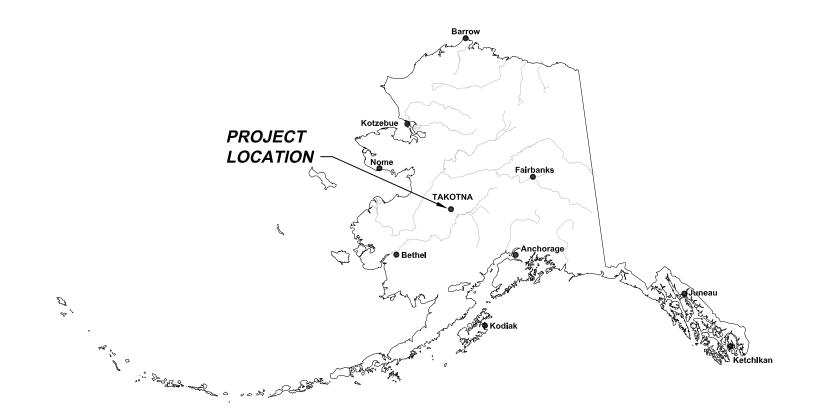

INDEX TO DRAWINGS

COVER SHEET


CIVI

C-1 WASHETERIA DEMOLITION PLAN

C-2 WASHETERIA SITE PLAN, FLOW DIAGRAM AND GENERAL NOTES


C-3 SEPTIC SITE PLAN

C-4 SEPTIC DETAILS

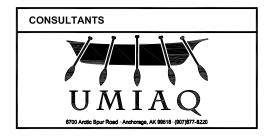

NOTES

- 1. OWNER: TAKOTNA COMMUNITY ASSOCIATION CONTACT: 888-856-6186
- 2. ELECTRIC UTILITY: TAKOTNA COMMUNITY ASSOCIATION INCORPORATED CONTACT: 888-856-6186
- 3. REMOVE EXISTING GIARDIA FILTER AND PRESSURE GAUGE.
- 4. REMOVE TWO EXISTING CARBON FILTER AND ASSOCIATED HARDWARE. VALVES FROM RAW WATER LINE TO REMAIN.
- 5. DO NOT REMOVE OR DAMAGE BACKWASH LINES OR VALVES.

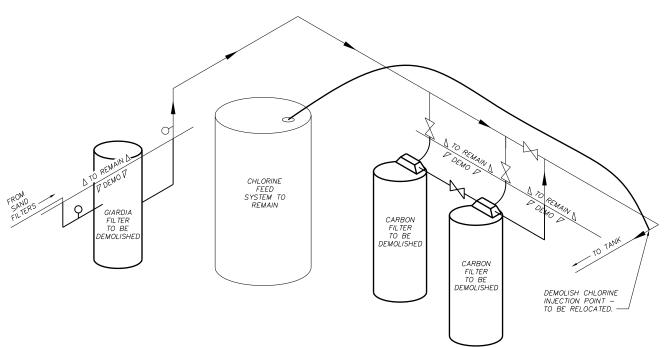



DEMOLITION PLAN

M: \Design\Engineering\PROJECTS\70108.13 Takot TED: 12/15/2013 18:44 David.Hardy LAYOUT:

SAND FILTER

DRAWN BY: MAR CHECKED BY: DH DATE: 12/16/2013 JOB NUMBER: 70108.13 SCALE: AS SHOWN

DRAWING TITLE: WASHETERIA DEMOLITION PLAN

SHEET: OF

C-1

WATER TREATMENT PLANT UPGRADE AND SEPTIC DRAINFIELD REPLACEMENT TAKOTNA, ALASKA

TAKOTNA TRIBAL COUNCIL

DRAWING TITLE: WASHETERIA SITE PLAN, FLOW DIAGRAM AND GENERAL NOTES

SHEET:

OF

GENERAL NOTES

OWNER: TAKOTNA COMMUNITY ASSOCIATION CONTACT: 888-856-6186

2. ELECTRIC UTILITY: TAKOTNA COMMUNITY ASSOCIATION INCORPORATED CONTACT: 888-856-6186

3. ALL ADDITIVES AND MATERIALS USED FOR THE POTABLE WATER SYSTEM SHALL BE APPROVED FOR USE BY THE NATIONAL SANITATION FOUNDATION (NSF) STANDARDS, NSF 61, NSF 53, AS APPLICABLE..

4. ALL MATERIALS FOR THE POTABLE WATER SYSTEM SHALL BE LEAD-FREE. ONLY LEAD FREE PIPE, FLUX, AND SOLDER SHALL BE

5. DESIGN DRAWINGS ARE SCHEMATIC IN NATURE, THEY ARE NOT INTENDED TO BE DETAILED DRAWINGS.

6. PROVIDE BACKFLOW AND CROSS CONNECTION CONTROL PER 18AAC80.

SCOPE OF WORK

DEMOLISH EXISTING GIARDIA FILTER AND CARBON FILTERS AS SHOWN ON SHEET C-1.

3. DISINFECT SYSTEMS AND DISPOSE OF NEUTRALIZED WATER PER THE REQUIREMENTS OF ANSI/AWWA C651, C652, C653. PRESSURE TESTING MAY BE CONDUCTED AT THE SAME TIME AS DISINFECTION PER ASNI/AWWA C605.

SYMBOL LEGEND

11,000 GALLON CHLORINE CONTACT/STORAGE TANK

CHLORINE CONTACT DESIGN CRITERIA MAX CT VOLUME PROVIDED: 10,394 GALLANS

SCHOOL PANEL

CHLORINE FEED

SCHOOL PUMPS

SYSTEM (P1)

SAND FILTER

FILTER

 \boxtimes

NEW SAMPLE

WASHETERIA PANEL

TAP TYP

WATER METER

- WASHETERIA PUMPS

7. ALL PIPING MATERIALS TO BE SCHEDULE 40 PVC.

2. INSTALL STAGE ONE AND STAGE TWO FILTERS AND ASSOCIATED VALVES AND PIPING.

4. UPON COMPLETION OF WORK, PERFORM TOTAL COLIFORM TESTING PER ADEC REQUIREMENTS PRIOR TO ESTABLISHMENT OF SERVICE TO WATER SYSTEM.

<u>EXISTING</u>		<u>P</u> F	<u>PROPOSED</u>	
下	SAMPLE TAP	下	SAMPLE TAP	
9	PRESSURE GAGE	ρ	PRESSURE GAGE	
\bowtie	VALVE	\bowtie	VAL VE	
M	METER	W	METER	
		_	FLOW DIRECTION	

DESIGN CRITERIA

WATER SOURCE:

<u>POPULATION*;</u> CURRENT: DESIGN:

PER CAPITA WATER USE*: WATERING POINT:

19 GPCPD (RECENT) WATER DISTRIBUTION: 25 GPCPD (RECOMMENDED)

AVERAGE DAILY DEMAND*: CURRENT:

WASHETERIA: SCHOOL: TOTAL: 950 GPD 627 GPD 1,577 GPD

MAXIMUM DAILY DEMAND*: CURRENT: 3,154 GPD

PEAK HOURLY DEMAND*:

CURRENT: 5.9 GPM (CURRENT MAXIMUM FILTRATION RATE: 7 GPM)

PEAK WATER DEMAND**: CURRENT: 41.5 GPM

SOURCE PUMPING RATE*: 37 GPM

<u>CT_TREATMENT:</u>
THE SYSTEM CAN MEET THE CT_REQUIREMENTS FOR_NORMAL_AVERAGE_AND_PEAK_FLOW THE SYSTEM CAN MEET THE CT REQUIREMENTS FOR NORMAL AVERAGE AND PEAK FLOW RATES (12 GPM AND 45 GPM RESPECTIVELY). ASSUMING A WATER TEMPERATURE OF 5 DEGREES CELSIUS, BAFFLE FACTOR OF 10%, 0.5 LOG TREATMENT, pH OF 6.5, AND A MINIMUM WATER STORAGE CAPACITY OF 7,800 GALLONS, THE SYSTEM CAN ADJUST FREE CHLORINE RESIDUAL LEVELS TO MEET CT REQUIREMENTS. AT 5.5 GPM FLOW RATE, THE SYSTEM WOULD HAVE TO MAINTAIN 0.3 MG/L FREE CHLORINE RESIDUAL AT 41.5 GPM FLOW RATES, THE SYSTEM WOULD HAVE TO MAINTAIN 1.2 MG/L FREE CHLORINE.

<u>PRE-FILTERS:</u>
SAND FILTERS ARE INSTALLED BEFORE THE PROPOSED STAGE 1 FILTERS TO REMOVE SILT AND LARGE PARTICLES PRIOR TO THE TREATMENT UNITS.


PROPOSED FILTERS: STAGE 1:

TWO (2) MUNI-1-2FL-304 MUNICIPAL HURRICANE FILTRATION SYSTEM CARTRIDGES WITH HC/170-5 HURRICANE HIGH PERFORMANCE FILTERS MANUFACTURED BY HARMSCO MUNICIPAL, OR APPROVED EQUAL.

STAGE 2

TWO (2) MUNI-1-2FL-304 MUNICIPAL HURRICANE FILTRATION SYSTEM CARTRIDGES WITH HC/170-LT2 HURRICANE ABSOLUTE RATED FILTERS MANUFACTURED BY HARMSCO MUNICIPAL OR APPROVED EQUAL.

* DATA FROM G.V. JONES WATER PLANT UPGRADE DESIGN - 1/6/2004 ** DATA FROM FIXTURE COUNT CONDUCTED IN DECEMBER, 2013

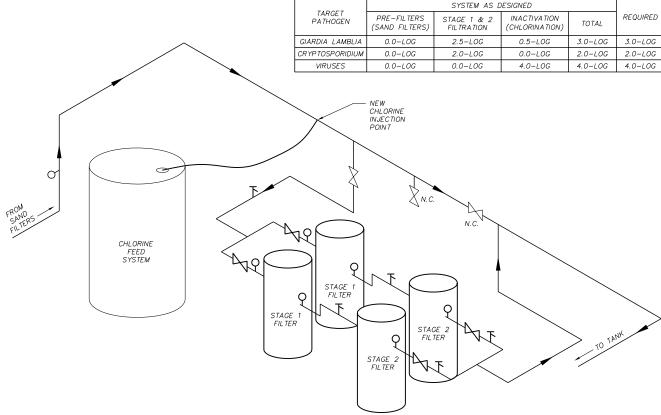




UTILITY SINK

FLOW SWITCH

NEW FILTERS -

NEW CHLORINE INJECTION POINT

(FS1) -

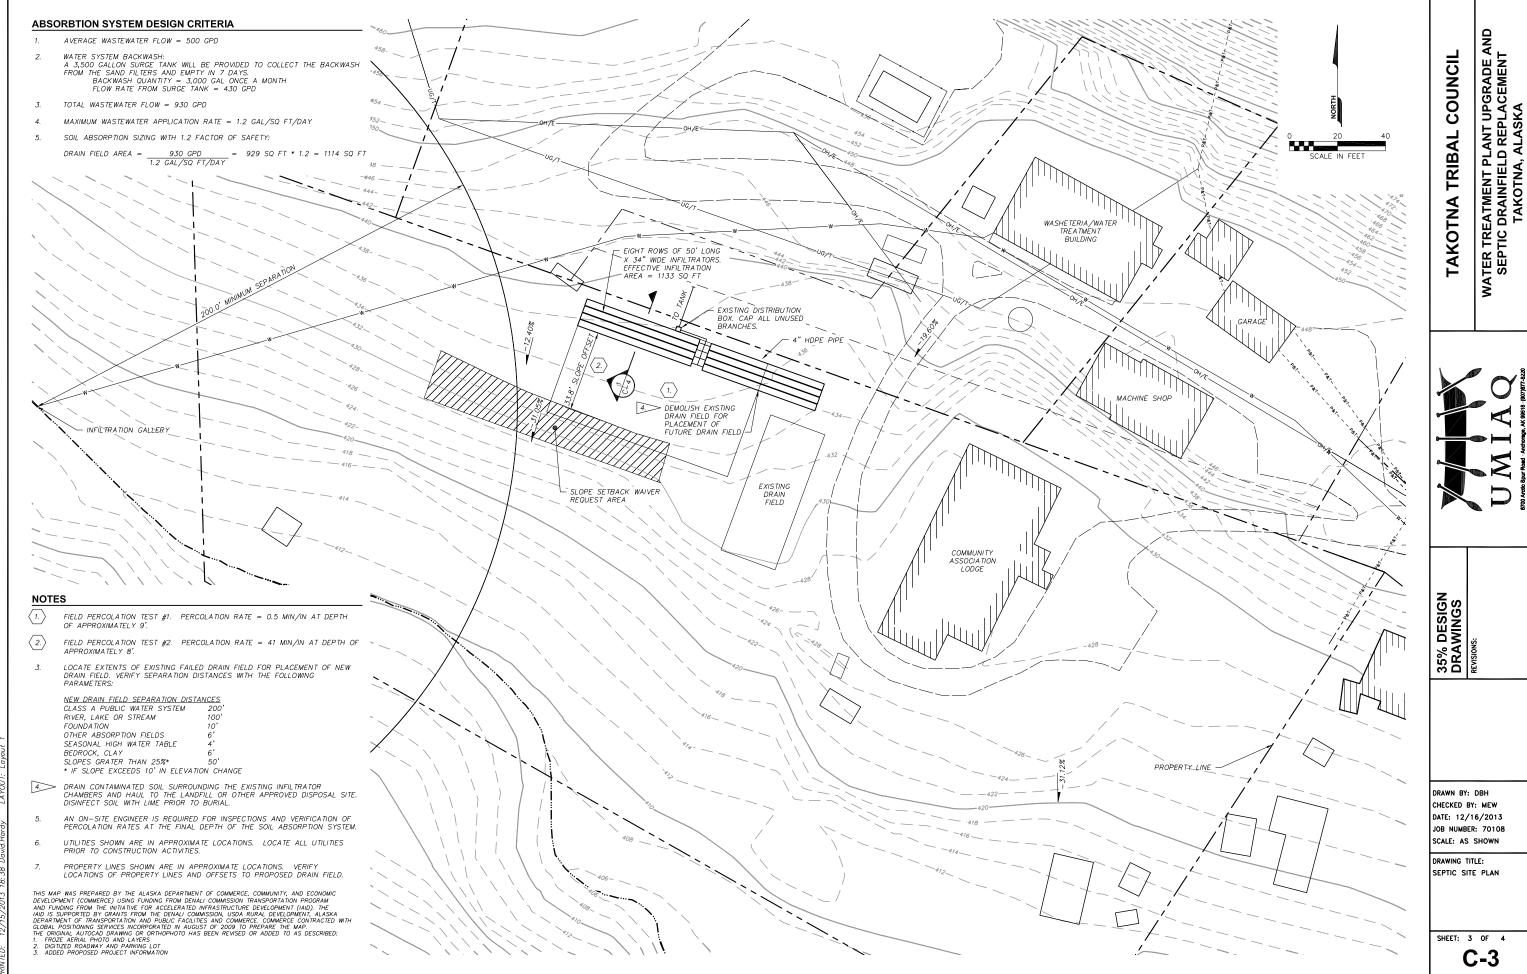

FILE: M. \Design\Engineering\PROJECTS\70108.13 Takotna Washeteria Filter and Septic\DESIGN\Drawings\CIVIL\BASE Auto DBNITTD: 12.415.2013 19:38 مينيا بيصول (الاسترادي المحرول) الاسترادات المحرول الاسترادات التحرول الاسترادات

NOTES: 1. PROVIDE CLEANOUT AT BOTH ENDS OF INFILTRATORS - 16 TOTAL. - ATTACH THREADED CLEANOUT ASSEMBLY - 4" PVC PIPE CUT TO FIT USE HOLE SAW TO CUT PRE-MARKED HOLE REST 4" PVC PIPE ON TOP OF INSPECTION PORT SEAT. SECURE IN PLACE WITH A DRYWALL SCREW

INSPECTION PORT DETAIL SCALE: N.T.S.

DRAIN FIELD SECTION

WATER TREATMENT PLANT UPGRADE AND SEPTIC DRAINFIELD REPLACEMENT TAKOTNA, ALASKA TAKOTNA TRIBAL COUNCIL

35% DESIGN DRAWINGS REVISIONS:

DRAWN BY: DBH CHECKED BY: MEW DATE: 12/16/2013 JOB NUMBER: 70108 SCALE: AS SHOWN

DRAWING TITLE: SEPTIC DETAILS

SHEET: 4 OF 4

C-4